



Exhibit B - Schedule of Values (Adjacent Ways)

Tempe Unified School District #3

Gililland Middle School Rebuild

June 17th, 2022

Div.	Description	GMP	
1B	Survey & Layout	13,500	
2A	Demolition	28,093	
3A	Concrete	412,367	
26A	Electrical (Offsite)	59,568	
31A	Earthwork	664,409	
33A	Site Utilities	194,179	
	Testing & Special Inspections	15,000	
	General Conditions	141,670	
	Project Contingency	45,835	
	Project / Design / Escalation Contingency	27,501	
	Liability Insurance	22,001	
	Builders Risk Insurance	11,000	
	Payment & Performance Bond	20,167	
	Gross Receipts Tax	96,529	
	Fee	81,587	
	TOTAL CONSTRUCTION COSTS:	1,833,406	



Exhibit A.1 - Adjacent Ways Estimate Detail Tempe Unified School District #3

Gililland Middle School Rebuild

June 17th, 2022

		ADJACENT WAYS		TOTAL	
DIV	DESCRIPTION		UNIT		DIVISION SUM
1B	Survey & Layout (Phase 01)	QUANTITY		COST	
ID	Site Survey				
	Establish Benchmark	20	Hours	1,800	
	Mass Grading & Limits	20	Hours	1,800	
	Asphalt & Curbs	80	Hours	7,200	
	Misc. Survey			0.040	
	Locating Services	1	LS	2,340	42 500
	Total Survey & Layout				13,500
2A	Demolition				
	Site Demolition				
	Demo Asphalt	2,500	SF	7,500	
	Demo Hardscape	500	SF	1,500	
	U.G. Demo	1	LS	12,000	
	Safe-Off for U.G. & Bldg. Demo	1	LS	5,993	
	Demolition Debris Removal	2	Loads	1,100	
	Total Demolition	2	Loaus	1,100	28,093
	Total Demonton				20,093
3A	Concrete				
	Site Concrete				
	Curb + Gutter (MAG Std Dtl 220-1, Type A)	2,699	LF	81,368	
	Single Curb (MAG Std Dtl 222, Type A)	2,941	LF	82,348	
	Sidewalk (MAG Std Dtl 230)	20,111	SF	100,722	
	Sidewalk ramps (2 per drive entrance)	4	EA	14,000	
	Driveway Entrance (COT Dtl T-320)	1,837	SF	27,966	
	7" thick concrete pavement (MAG AA concrete)	9,272	SF	86,079	
	Valley Gutter (Mag Std Dtl 240)	225	LF	7,200	
	Light Pole Base - Beck Ave	3	EA	7,500	
	Roll Curb (not keynoted)	108	LF	5,184	
	Total Concrete				412,367
26A	Electrical				
	Site Electrical				
	Street Lights - Offsite (6/29 email)	3	EA	59,568	
	Total Electrical				59,568
31A	Earthwork				
	<u>Grading</u>				
	Mobilization, Mass Grading	2	EA	14,000	
	Clear & Grub		Acres		
	Cut/Fill Operations	1,500	CY/ALLO	33,000	
	Mobilization, Fine Grading	2	EA	13,000	
	Fine Grading	98,873	SF	87,008	
	Temp Fire Lane, 4"ABC	2,000	SY	7,500	
	Mobilization, Asphalt Pavement	4	EA	18,000	
	Asphalt: 3" AC over 8" ABC	7,640	SY	305,600	



Exhibit A.1 - Adjacent Ways Estimate Detail Tempe Unified School District #3

Gililland Middle School Rebuild

June 17th, 2022

		ADJACENT WAYS		TOTAL	
DIV	DESCRIPTION	QUANTITY	UNIT	COST	DIVISION SUM
	Sawcut, R&R 2' of existing asphalt (COT Dtl 316)	264	SY	27,720	
	Temporary Retention Basin	1,500	SF	7,200	
	Slurry Seal (MAG 332)	500	SY	11,000	
	Striping & Signage			,	
	Red Curb	5,545	LF	16,635	
	Parking Space, Striping	50	EA	5,000	
	Misc. Earthwork			,	
	Traffic Control, Barricades	8	Weeks	29,440	
	U.G. Demolition & Site additional site U.G Survey	1	LS	26,745	
	Dust Control Permit	1	LS	1,560	
	Water Mover / setup Temp Hydrant	250	LF	7,500	
	Dust Control, 4,000 Gallon Water Truck	4	Months	22,000	
	Dust Control, Water Truck Driver	240	Hours	13,200	
	Street Sweeping	8	Weeks	15,000	
	Construction Water	6	Months	3,300	
	Total Earthwork		WOTHERS	0,000	664,409
	Total Eartimon				004,400
33A	Site Utilities				
	Domestic Water				
	Coordinate w/ COT Water Dept for removal of existing water meter + service	1	EA	5,000	
	Install new 2" Landscape water service + meter w/ meter box and cover	6	EA	23,100	
	2" RPBFP (COT Std Dtl T-213)	5	EA	19,250	
	Install new 2" domestic water service + meter w/ meter box and cover	4	EA	19,400	
	Install 4" PVC Schedule 40 water line	18	LF	1,944	
	04C - 3" Gate Valve w/ VB&C	2	EA	7,700	
	Install new 2" reduced pressure backflow preventer	5	EA	19,250	
	8" Water Line	45	LF	4,860	
	8"x8" Tapping sleeve and 8" gate valve with VB&C	1	EA	3,500	
	Concrete encase existing sewer line	32	LF	6,400	
	Ex. 3" Domestic Water Meter and Vault to be removed	1	EA	3,500	
	Sewer			2,20	
	Connect to building sewer line	1	EA	2,500	
	Construct sewer building connection (MAG Std Dtl 440-1, Type A)	1	EA	4,800	
	Install 4" PVC SDR-35 sewer line	30	LF	2,940	
	Install 5' diameter sewer manhole w/ 30" frame + cover	2	EA	13,000	
	Install 8" PVC SDR-35 sewer line	12	LF	1,536	
	8" VCP Sewer Line	13	LF	1,664	
	Flood Irrigation	10	_,	1,004	
	15" Irrigation line	45	LF	4,185	
	Tie into existing Water	1	EA	2,850	
	Misc. Site Utilities	'	LA	2,000	
	Vertically realign water line to go beneath sewer line	6	EA	46,800	
	Total Site Utilities		LA	70,000	194,179


GILILLAND MIDDLE SCHOOL NEW CONSTRUCTION TEMPE SCHOOL DISTRICT NO.3 1025 S BECK AVE, TEMPE, AZ 85281



JOB No: SHEET:

AS101 80 57

IST FLR KEY PLAN

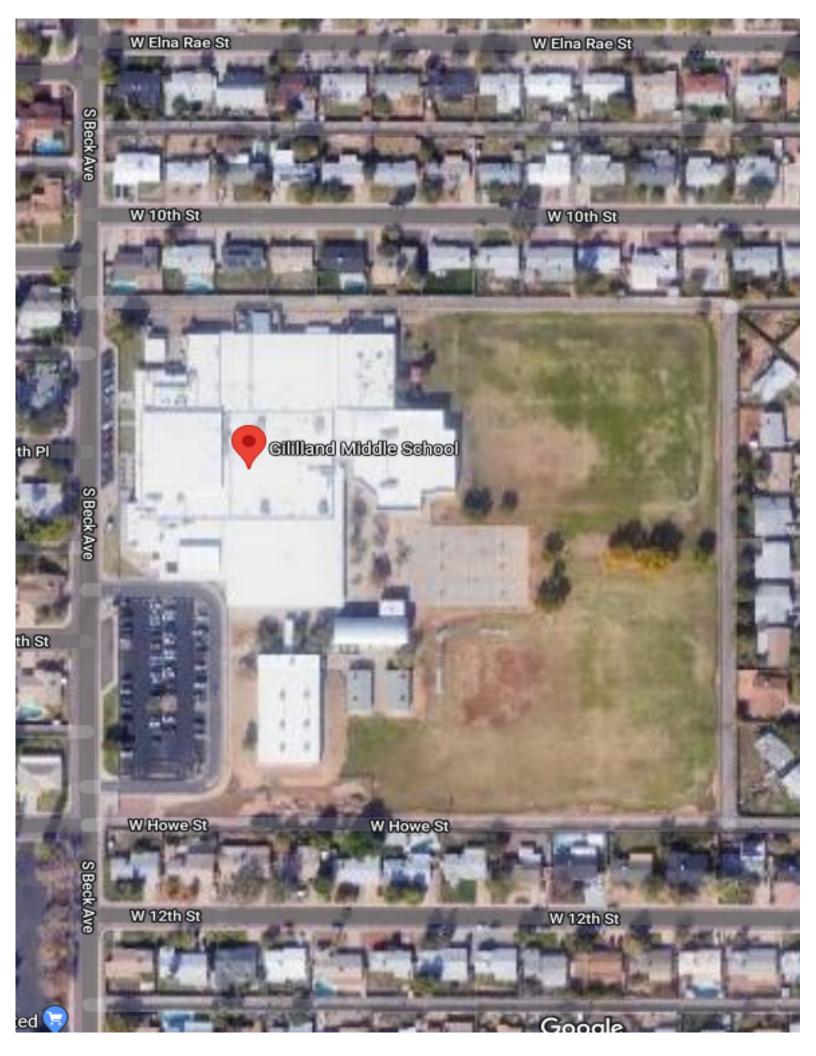

MARK DATE DESCRIPTION

2 02/07/22 1ST CITY COMMENT

3 02/21/22 CLASH COORD.

6 04/06/22 2ND CITY
COMMENTS

REVIEWED BY: ST

REVIEWED BY: ST DRAWN BY: MD


DATE: 11-30-2

JOB No: 2100

AS10

1ST FLR KEY PLAN

BUILDING 2

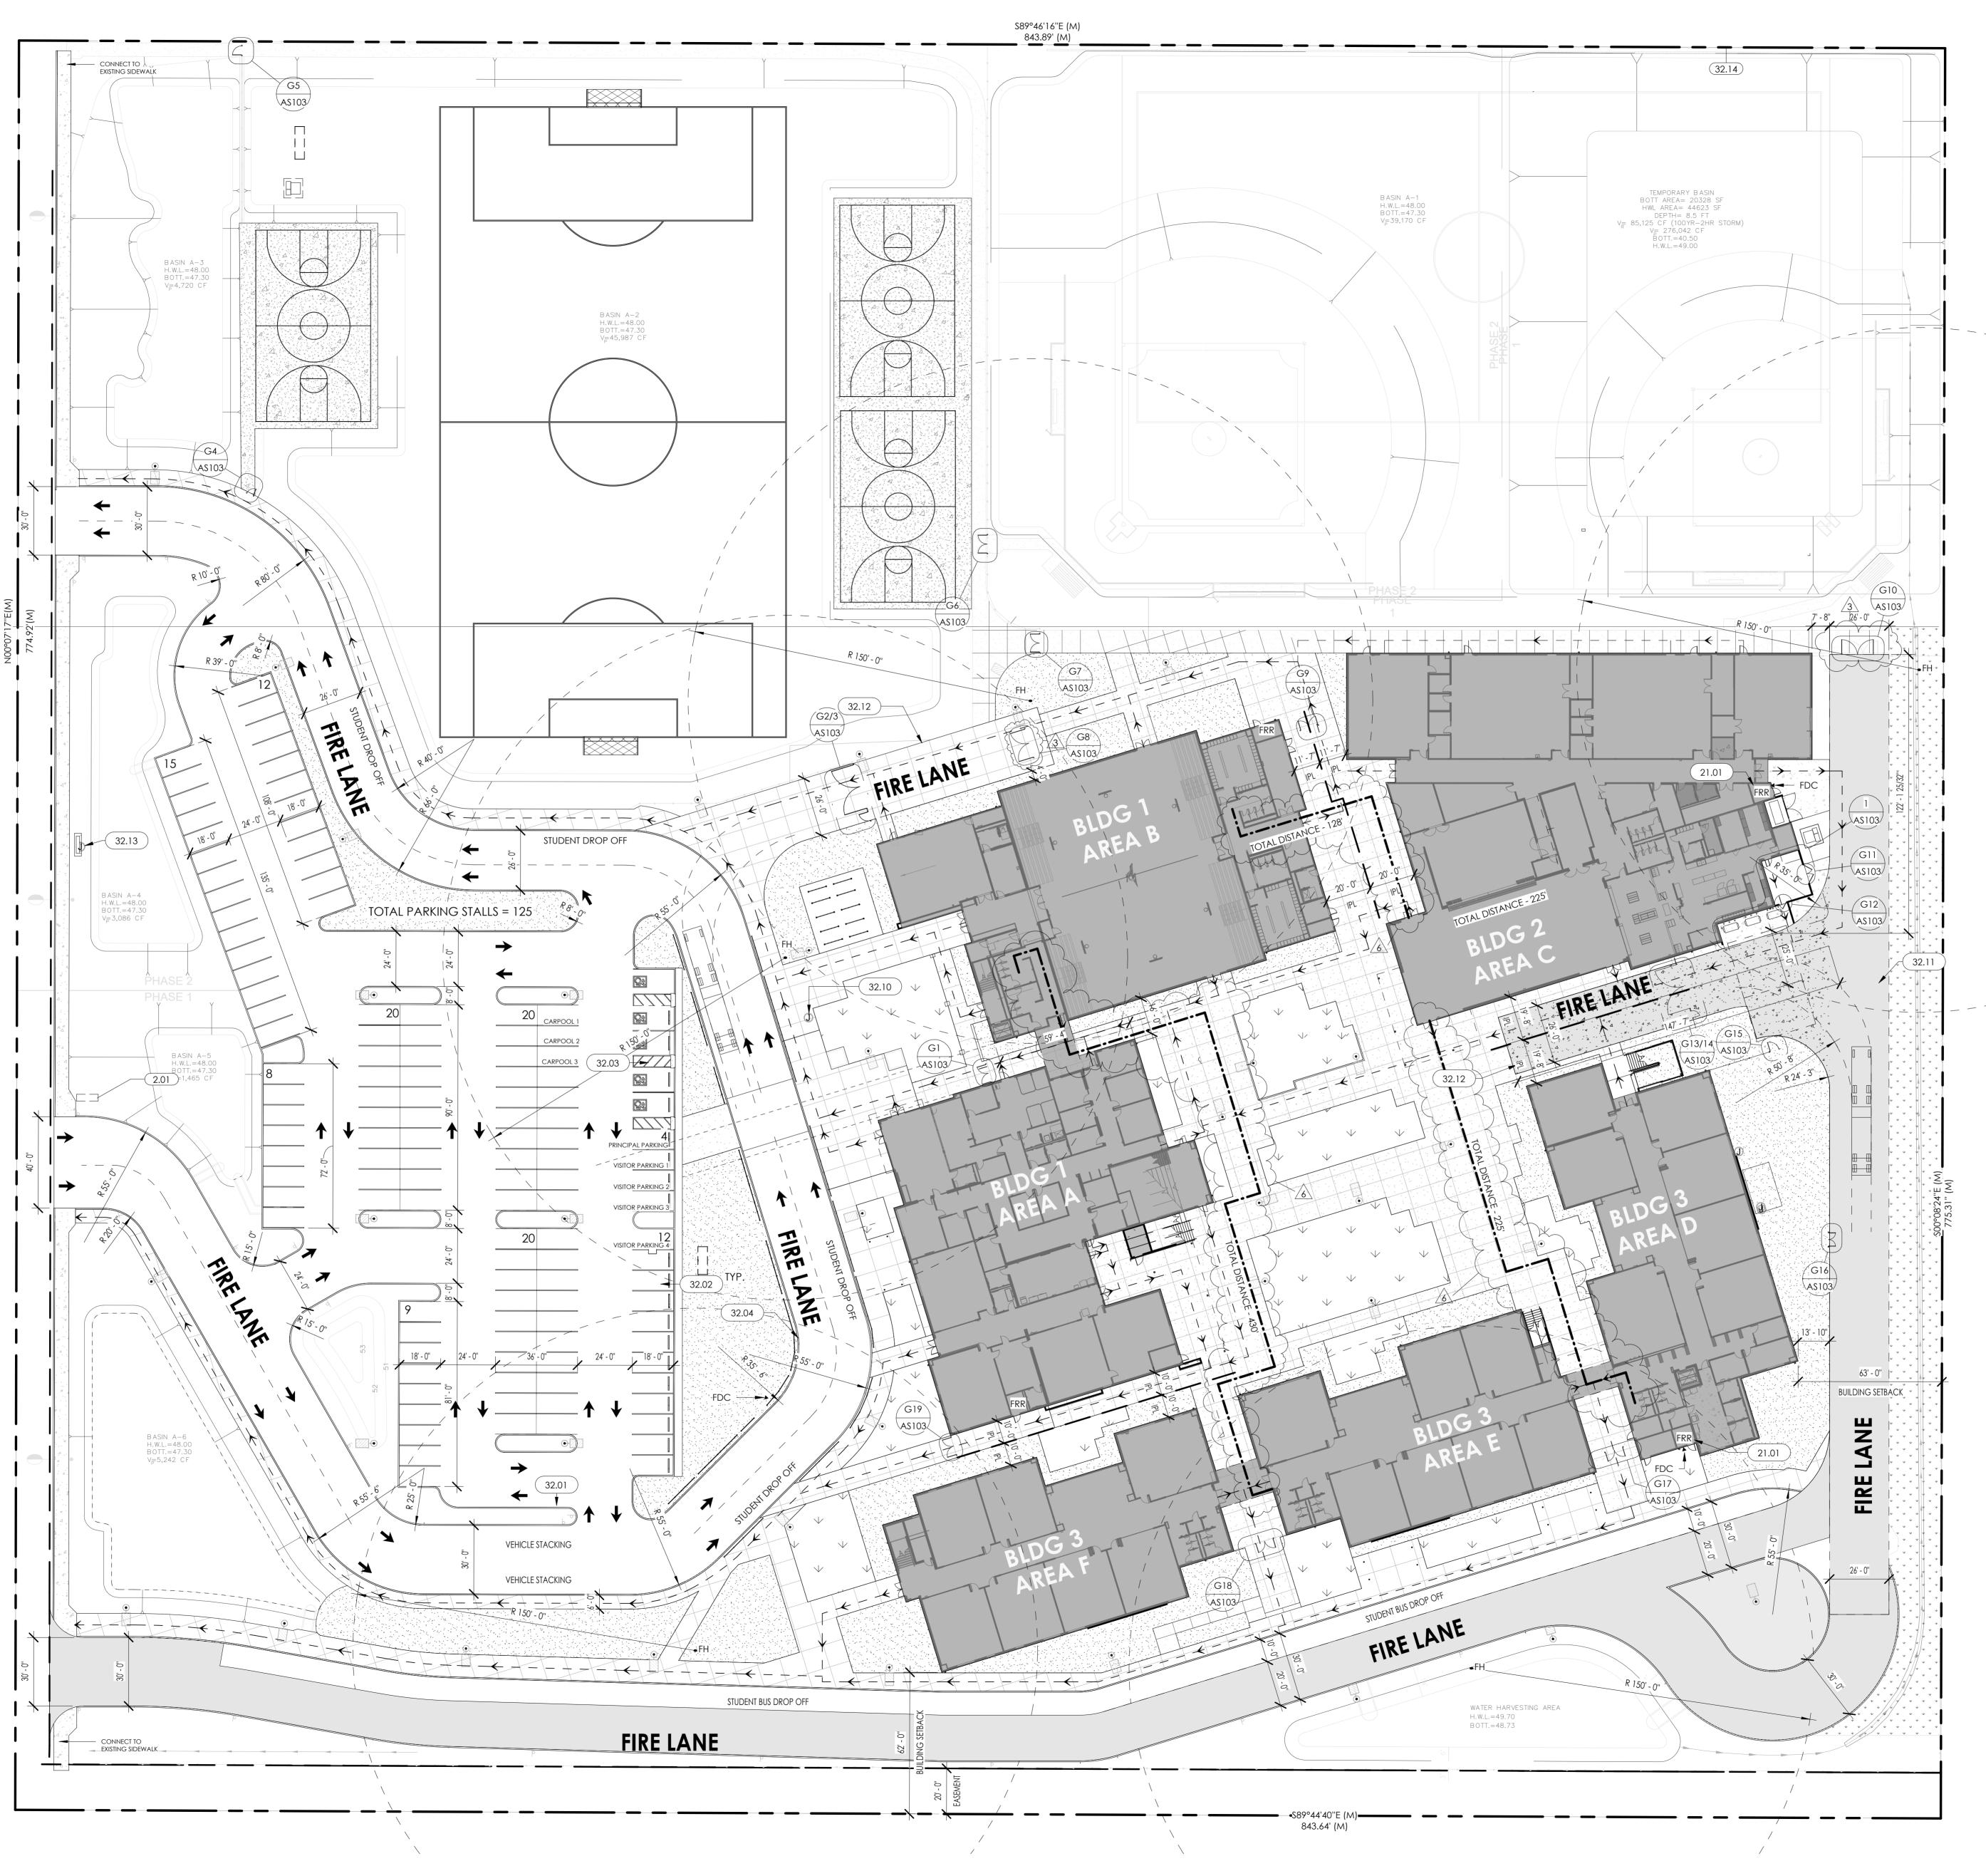

KEY NOTES

- 2.01 EXISTING MARQUEE TO BE RELOCATED. PROTECT FROM DAMAGE DURING REMOVAL. SEE ARCHITECTURAL SITE PLAN FOR NEW LOCATION.
- 21.01 FIRE RISER ROOM.32.01 NEW 6" VERTICAL CURB. REFER TO CIVIL PLANS & DETAILS.
- 32.02 NEW PARKING STALL STRIPING PER CITY OF TEMPE REQUIREMENTS.
 32.03 NEW HANDICAP PARKING STALL STALL PAINTING & SIGNAGE PER CITY
- OF TEMPE REQUIREMENTES.

 32.04 PROVIDE FIRE LANE CURB PAINTING, STENCILING AND SIGNAGE PER CITY OF TEMPE.
- 32.10 NEW FLAG POLE
- 32.11 ASPHALT FIRE LANE DRIVE
- 32.12 CONCRETE FIRE LANE DRIVE
 32.13 EXISTING MARQUEE TO BE RELOCATED.
- 32.14 CHAIN LINK FENCE @ PORPERTY LINE. REFER TO LANDSCAPE FOR

SITE HATCHES & SYMBOLS

FIRE LANE (ASPHALT)

► FDC

© FH FIRE HYDRANT

• FGL PL FLAG POLE

FIRE LANE (CONCRETE)

CONCRETE PAVING

PEDESTRIAN EGRESS PATH TO PUBLIC WAY ACCESSIBLE ROUTE

TRAVEL PATH TO PLUMBING FIXTURE

IMAGINARY PROPERTY LINE (IPL)

PLAN NORTH

SITE PLAN - OVERALL

1" = 30'-0"